

CITY OF TURLOCK CAPITAL PROJECT NO. 22-030 SENIOR CENTER SLIDING GLASS DOORS


SHEET INDEX

SHEET


ET DESCRIPTION

- 1 SHEET INDEX, LEGEND & VICINITY MAP
- DEMOLITION PLAN BANQUET AREA
- IMPROVEMENT PLAN BANQUET AREA

1191 CAHILL STREET

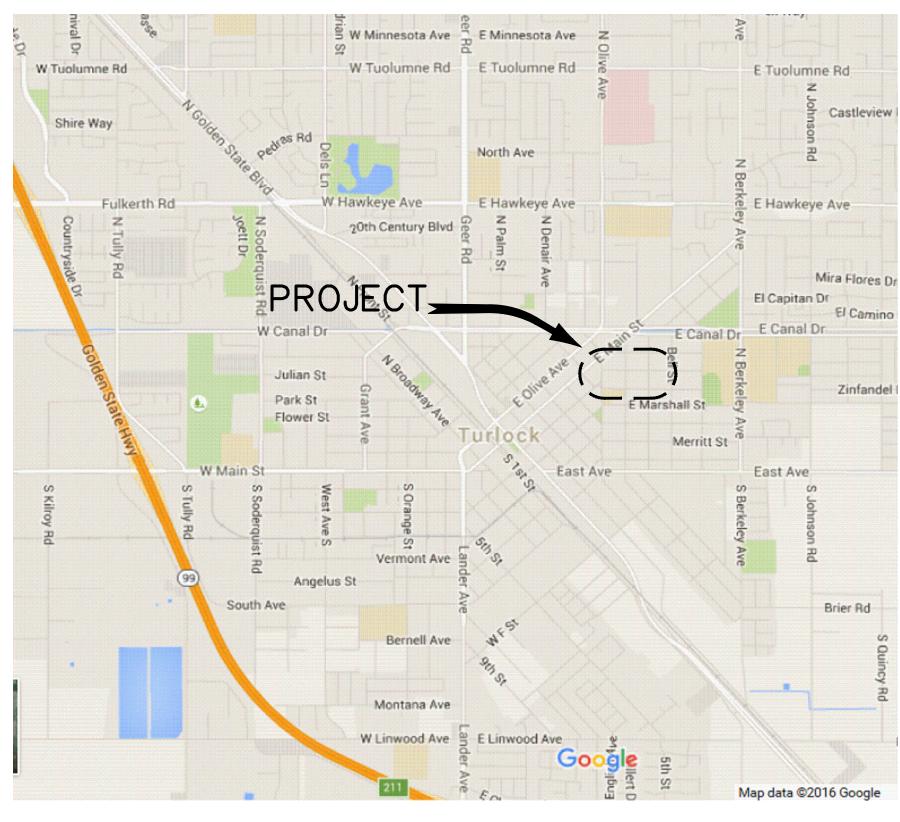

VICINITY MAP

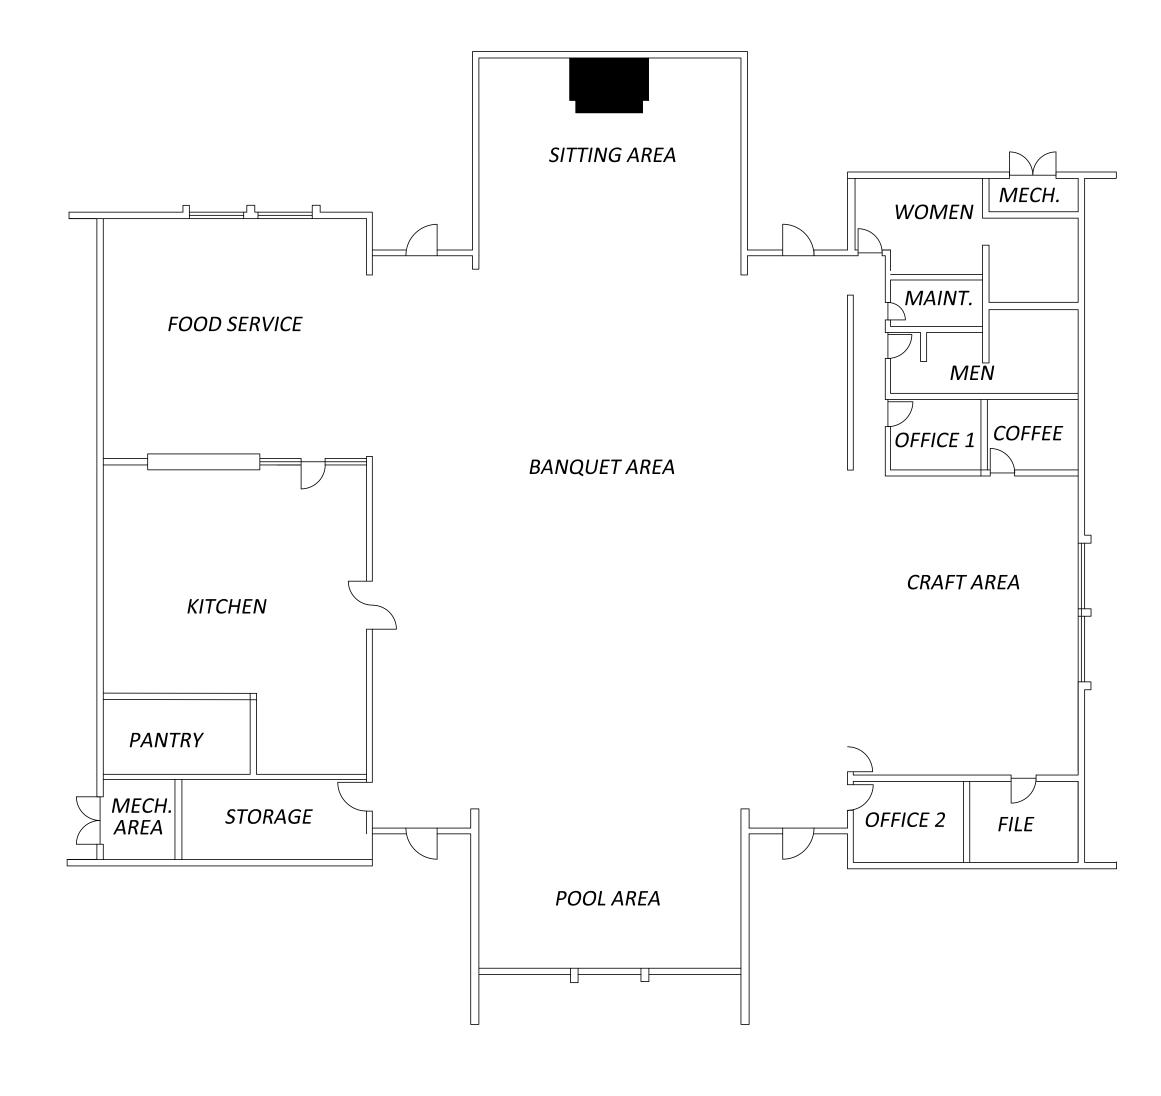

EXISTING FLOOR PLAN SCALE: 1"=10'

CONTACTS

CITY OF TURLOCK, PUBLIC WORKS DEPARTMENT (209) 668-5520 ENGINEERING DIVISION

<u>FIRE DEPARTMENT</u> (NON-EMERGENCY) (209) 668-5580

<u>POLICE DEPARTMENT</u> (NON-EMERGENCY) (209) 668-1200

MBULANCE

<u>AMBULANCE</u> (209) 632–2271

TURLOCK SCAVENGER (209) 668-7274

TURLOCK FACILITY MAINTENANCE

SCOTT TAYLOR (209) 321-1703

SENIOR CENTER ACCESS POINT OF CONTACT
JUAN VARGAS (209) 668-6013

NOTE:
ALL REFERENCES AND WRITTEN
DIMENSIONS SHALL SUPERCEDE
ALL SCALED DISTANCES AND
SHALL BE VERIFIED IN THE
FIELD. ANY DISCREPANCY SHALL
BE BROUGHT TO THE ATTENETION
OF THE ENGINEER PRIOR TO
THE COMMENCEMENT OF WORK.

STEPHEN FREMMING, P.E. PRINCIPAL CIVIL ENGINEER

DATE: 3/13/2023



CITY OF TURLOCK
PUBLIC WORKS DEPARTMENT
ENGINEERING DIVISION
156 S. BROADWAY, STE 150
(209) 668-5520


SHEET INDEX, LEGEND & VICINITY MAP

CAPITAL PROJECT NO. 22-030

SENIOR CENTER


SLIDING GLASS DOORS


RAWN BY: CC	SHEET
PEV. BY: SF	1
H. BY: SF	
ATE: FEB 2, 2023	I
CALE: SCALE	7
22-030.DWG	OF 3

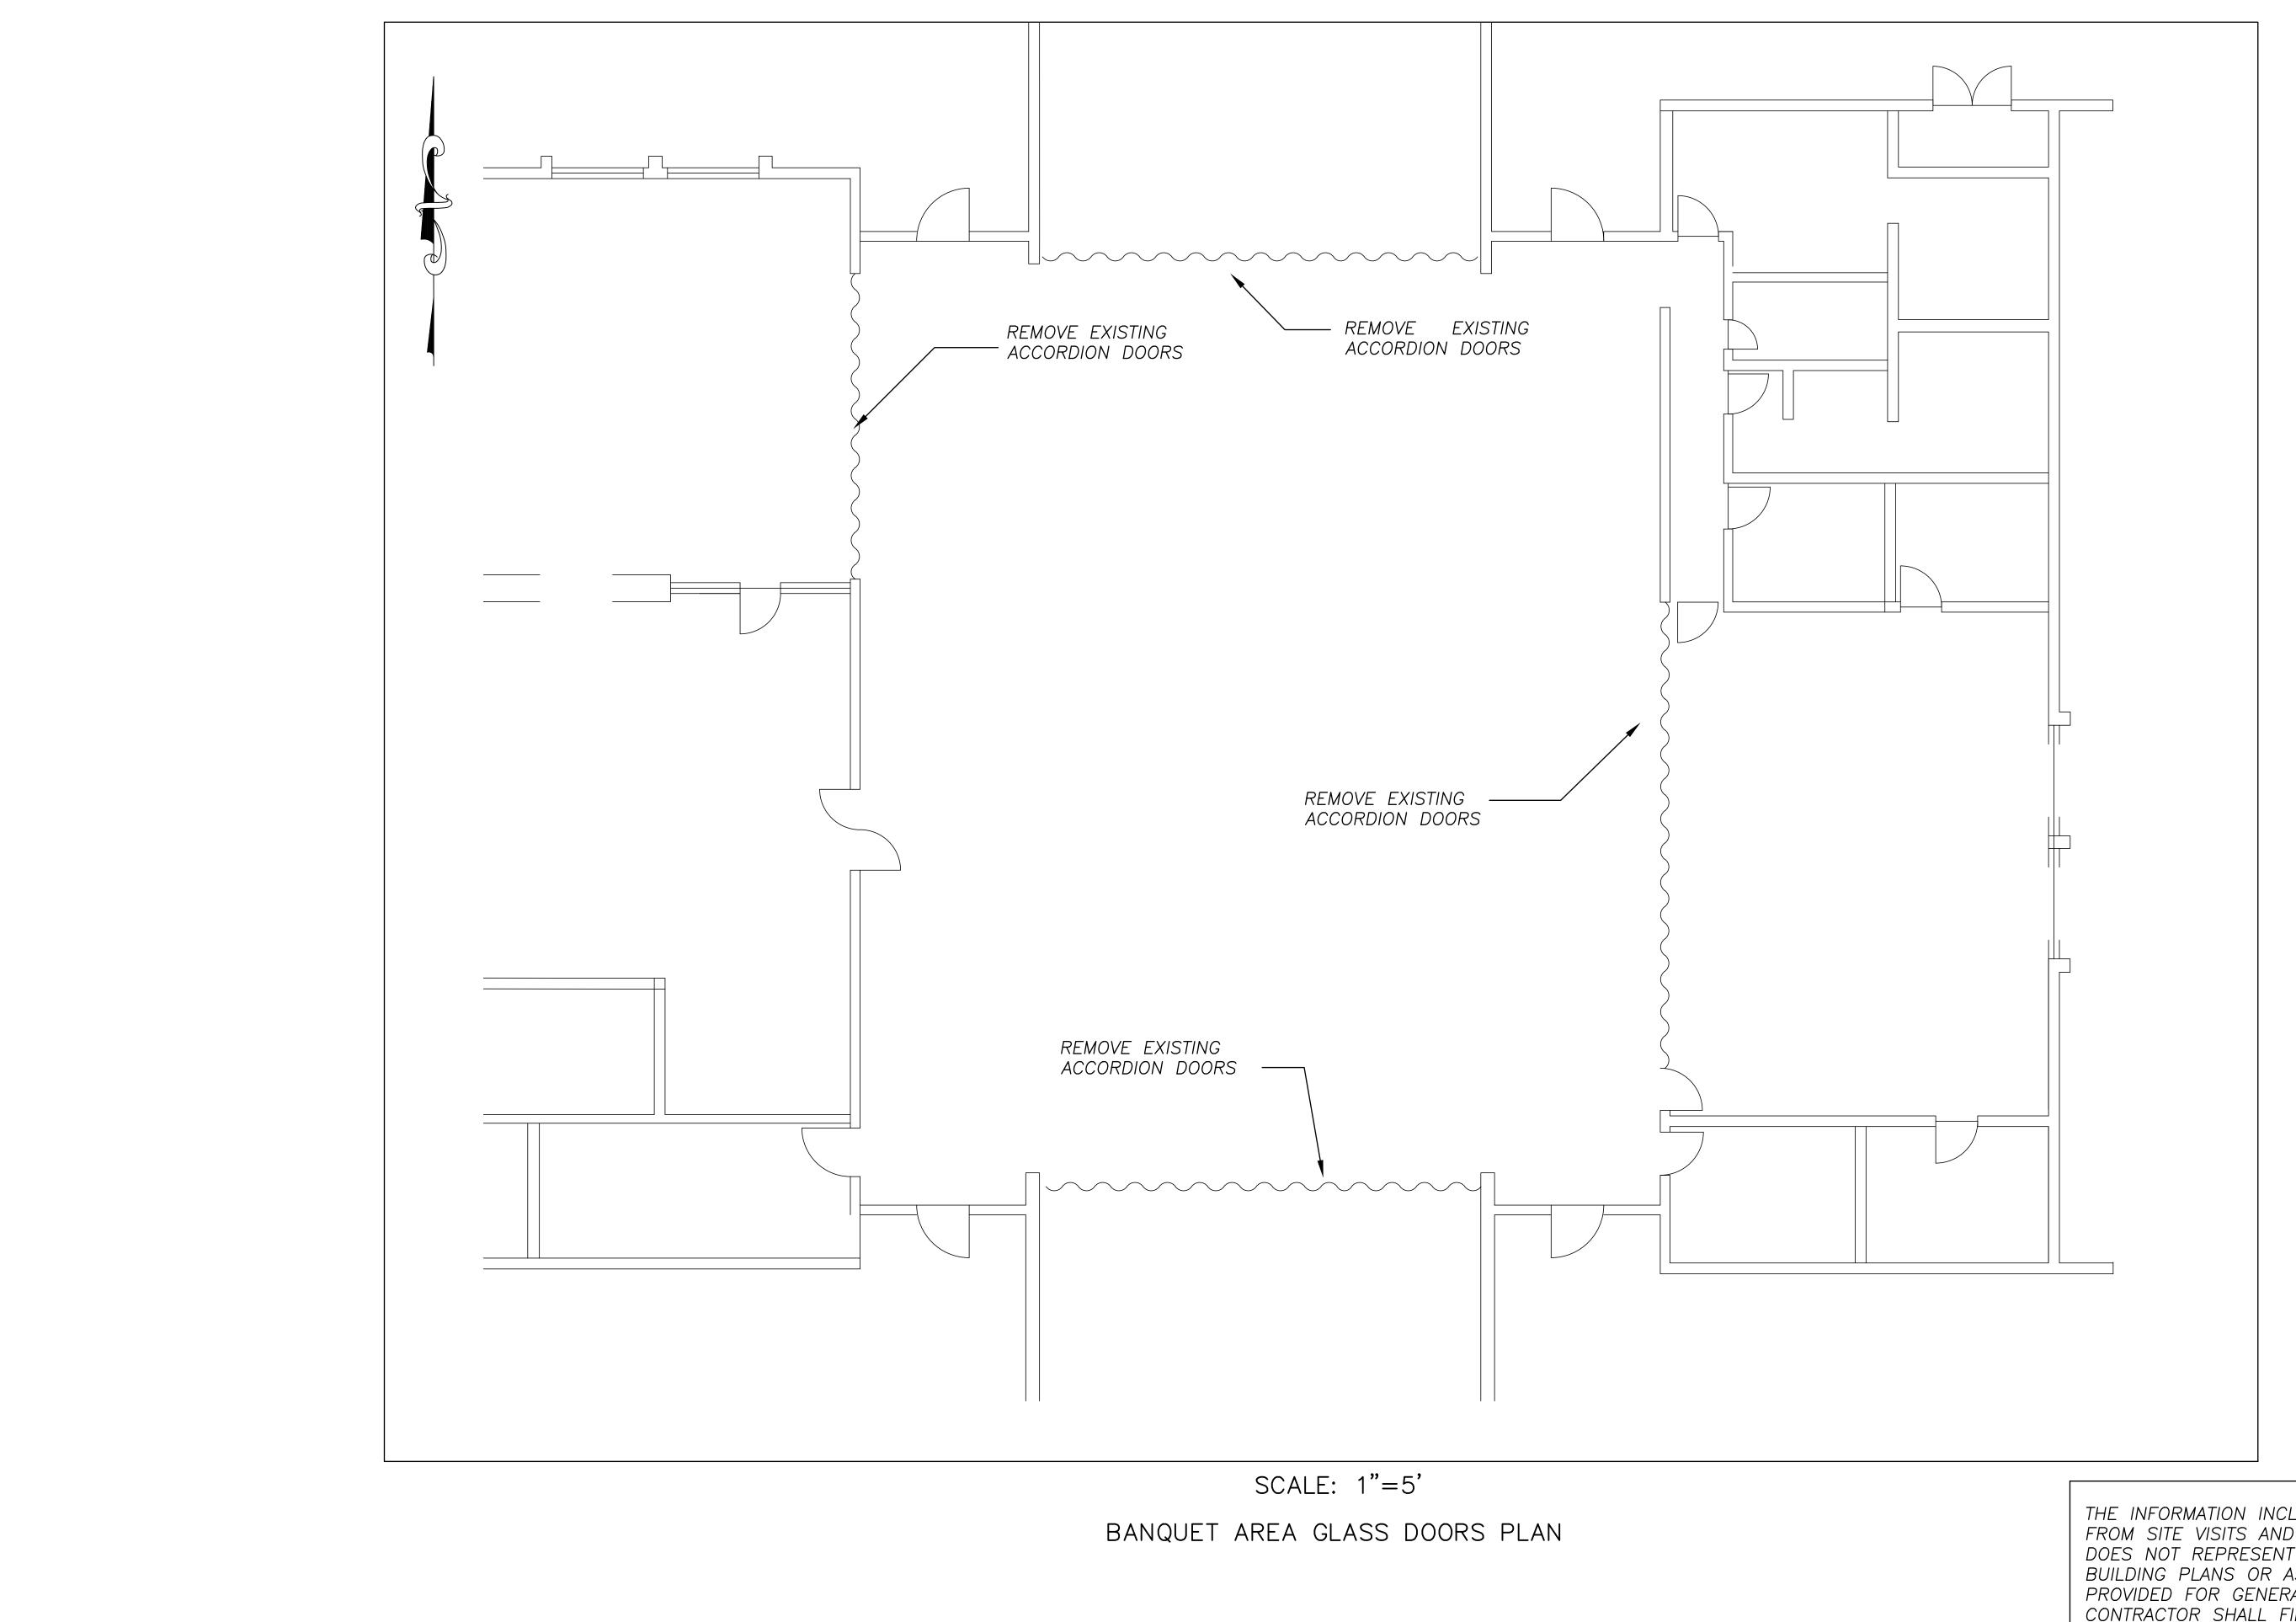

THE INFORMATION INCLUDED ON THIS SHEET HAS BEEN COMPILED FROM SITE VISITS AND MEASUREMENTS TAKEN IN THE FIELD AND DOES NOT REPRESENT THE DIMENSIONS SHOWN ON ORIGINAL BUILDING PLANS OR AS—BUILT DRAWINGS. THESE GRAPHICS ARE PROVIDED FOR GENERAL SCHEMATIC PURPOSES ONLY. CONTRACTOR SHALL FIELD VERIFY DIMENSIONS PRIOR TO ORDERING MATERIAL QUANTITIES OR PLANNING THE WORK.

NOTE:
ALL REFERENCES AND WRITTEN
DIMENSIONS SHALL SUPERCEDE
ALL SCALED DISTANCES AND
SHALL BE VERIFIED IN THE
FIELD. ANY DISCREPANCY SHALL
BE BROUGHT TO THE ATTENETION
OF THE ENGINEER PRIOR TO
THE COMMENCEMENT OF WORK.

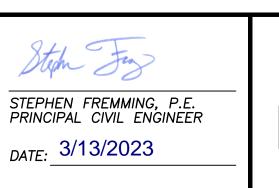

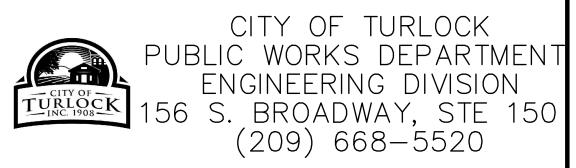

DEMOLITION PLAN


CAPITAL PROJECT NO. 22-030 SENIOR CENTER SLIDING GLASS DOORS


VERIFY SCALE	
BAR IS 1" ON ORIGINAL DRAWING	
1/4" 3/4"	
0 1/2"	
IF NOT ONE INCH ON THIS SHEET, ADJUST SCALES ACCORDINGLY	


,	DRAWN BY: CC	SHE
;	REV. BY: SF	l ,
1"	CH. BY: SF	(
'	DATE: FEB 2, 2023	\
ON ST	SCALE: SCALE	

22-030.DWG

OF 3

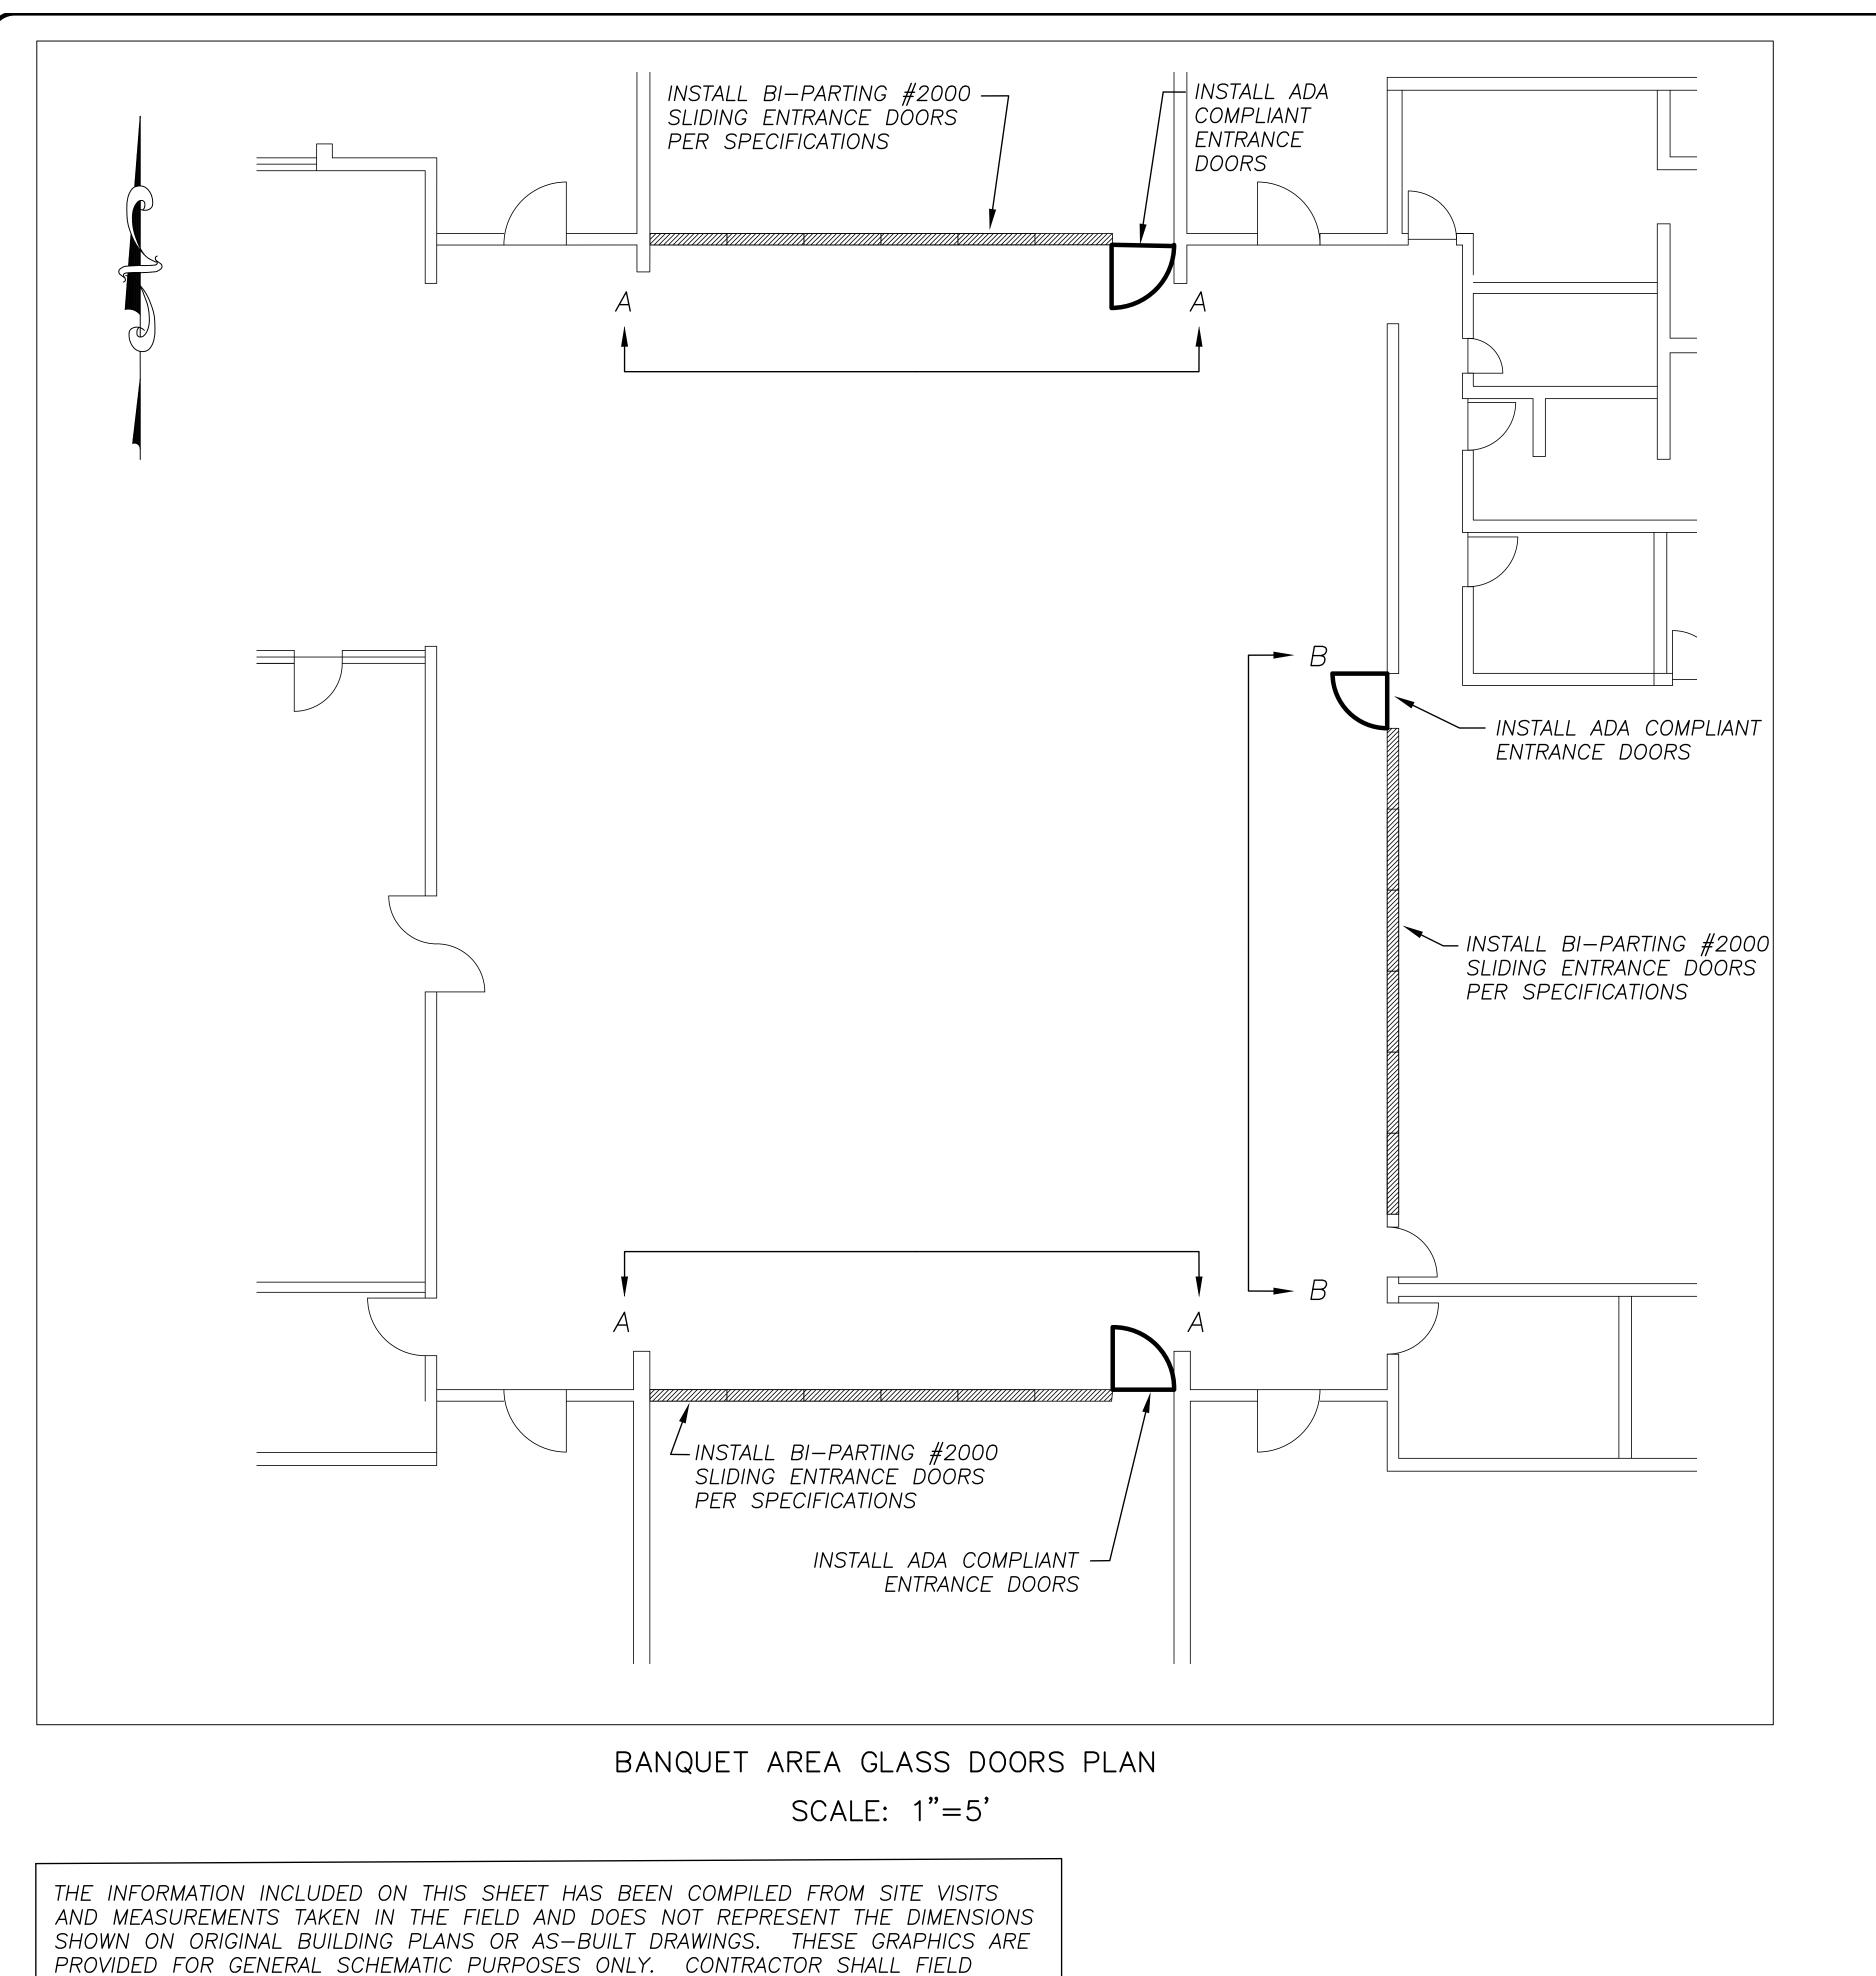

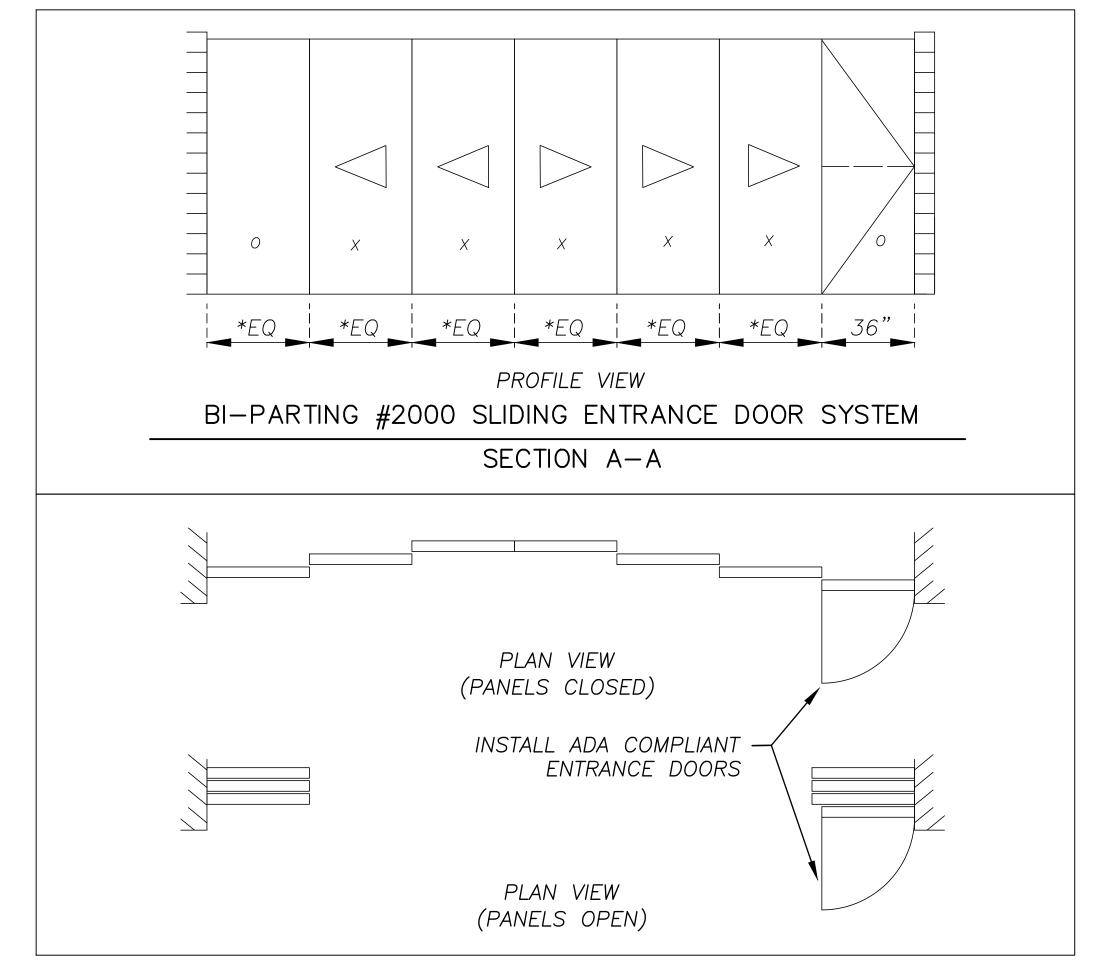

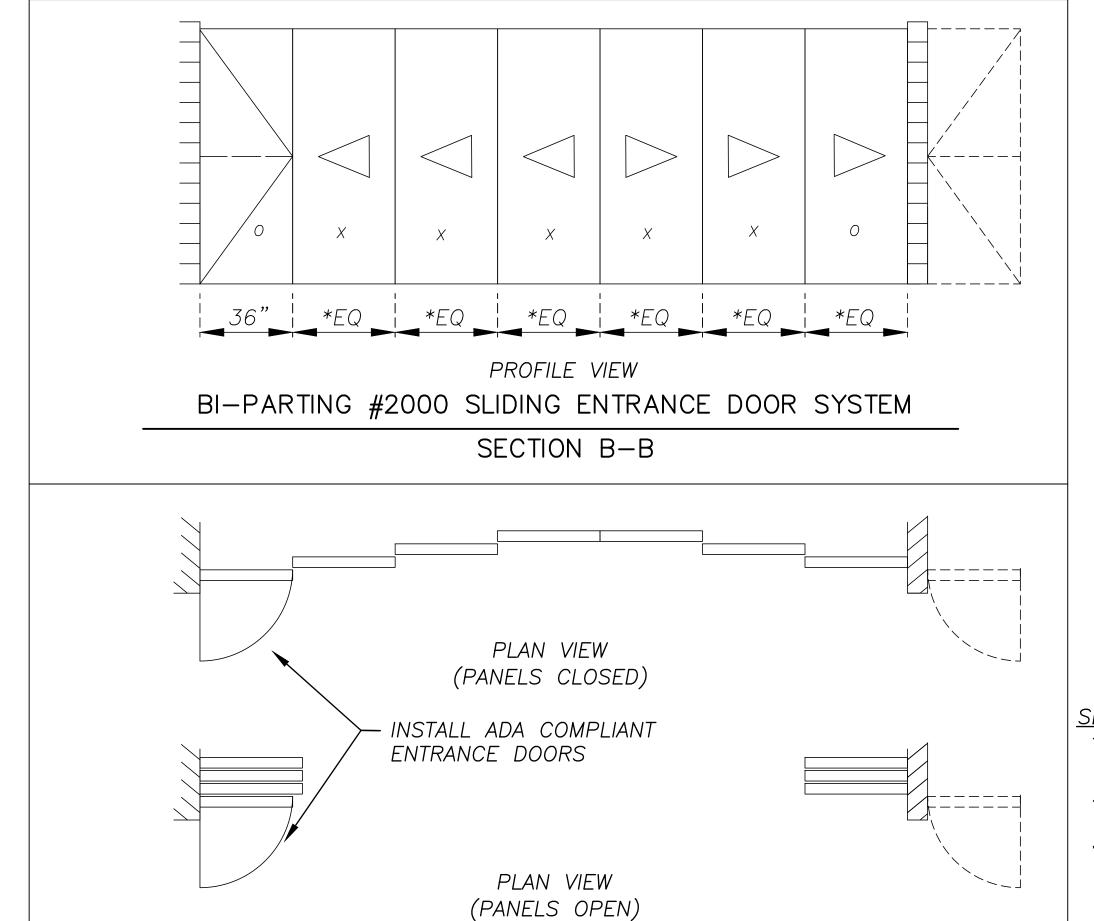

SECTION NOTES

- 1. "X" INDICATES SLIDING GLASS PANELS
- 2. "O" INDICATES FIXED
- GLASS PANELS
- 3. *SLIDING AND FIXED GLASS PANELS SHALL BE UNIFORM SIZE (*EQ)

ALL REFERENCES AND WRITTEN
DIMENSIONS SHALL SUPERCEDE
ALL SCALED DISTANCES AND
SHALL BE VERIFIED IN THE FIELD. ANY DISCREPANCY SHALL BE BROUGHT TO THE ATTENETION OF THE ENGINEER PRIOR TO THE COMMENCEMENT OF WORK.

VERIFY DIMENSIONS PRIOR TO ORDERING MATERIAL QUANTITIES OR PLANNING THE WORK.

STEPHEN FREMMING, P.E. PRINCIPAL CIVIL ENGINEER DATE: 3/13/2023



CITY OF TURLOCK
PUBLIC WORKS DEPARTMENT
ENGINEERING DIVISION 156 S. BROADWAY, STE 150 (209) 668-5520 IMPROVEMENT PLAN - BANQUET AREA

CAPITAL PROJECT NO. 22-030 SENIOR CENTER SLIDING GLASS DOORS

VERIFY SCALE		
BAR IS 1" ON ORIGINAL DRAWING		
1/4" 3/4"		
01"		
1/2"		
IF NOT ONE INCH ON THIS SHEET, ADJUST SCALES ACCORDINGLY		

DRAWN BY: CC	SHEET
REV. BY: SF	
CH. BY: SF	\Box ()
DATE: FEB 2, 2023	$\bigcup_{i} \mathcal{O}_{i}$
SCALE: SCALE	7
22-030.DWG	OF 3